verizonwireless

APPLICANT

VERIZON WIRELESS
MANAGER-NETWORK REAL ESTATE
PHONE: (913) 244-2800

SITE ACQUISITION

KGI PHONE: (417) 848–7584

SURVEYOR

HUSKER SURVEYING PHONE: (402) 423-5202

ARCHITECTURAL AND ENGINEERING FIRM

MAGTECH MIDWEST, INC. PHONE: (260) 436-2668 POLICE DEPARTMENT

LAWRENCE POLICE DEPT. 111 EAST STREET LAWRENCE, KS 66044 PHONE: (785) 830-7400

FIRE DEPARTMENT

LAWRENCE FIRE DEPARTMENT 1911 STEWART AVENUE LAWRENCE, KS 66046 PHONE: (785) 830-7000

PROPERTY OWNER

STEVE L. EUDALY

KANSAS ONE-CALL SYSTEM 811 OR 1-800-DIG SAFE



CONSULTANT TEAM

THE PROJECT INCLUDES:

INSTALLATION OF PANEL ANTENNA, ASSOCIATED COAX AND OTHER EQUIPMENT IN NEW 120' MONOPOLE TOWER.

INSTALLATION OF A 27'-4 1/2"x11'-6" UNMANNED EQUIPMENT SHELTER WITH GENERATOR ON A CONCRETE FOUNDATION.


NEW ELECTRIC AND TELEPHONE/FIBER SERVICE TO SITE AND EQUIPMENT SHELTER. NO WATER SUPPLY OR SEWAGE TO/FROM THE SITE.

SITE LAT/LON ELEV.

LATITUDE - N38° 57′ 8.89″ LONGITUDE - W95° 13′ 34.91″ GRD ELEV. - ±843.0′ AMSL

CONTRACTORS ATTENTION IS CALLED TO EES FOR THIS SITE. SITE HAS RESTRICTIONS ON EXCAVATION/CONSTRUCTION METHODS. STAGE AND STOCKPILING OF EXCAVATED MATERIALS ARE RESTRICTED IN SOME AREAS. AN EROSION PREVENTION AND SEDIMENT CONTROL PLAN IS PART OF THESE PLANS. BEST MANAGEMENT PRACTICES ARE TO BE USED DURING CONSTRUCTION. DIESEL FUEL IS ALSO PROHIBITED AT THE SITE WITH THE EXCEPTION OF FUEL IN THE TANK OF A VEHICLE.

PROJECT DESCRIPTION

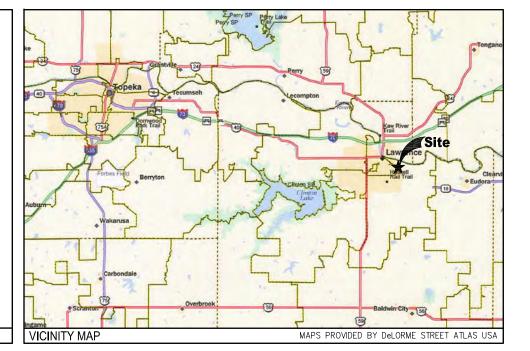



LAWC BARKER CELL SITE

BULLENE AVENUE LAWRENCE, KS 66044 DOUGLAS COUNTY

LOCATION No: 273487 PROJECT No: 20130934055

PROPOSED MONOPOLE WITH COMMUNICATIONS EQUIPMENT

- ANY TELECOMMUNICATIONS FACILITY THAT IS NOT IN USE FOR A PERIOD OF THREE (3) FULL YEARS OR MORE SHALL BE REMOVED BY THE OWNER AT THE OWNERS EXPENSE. FAILURE TO REMOVE THE TELECOMMUNICATIONS FACILITY PURSUANT TO NON-USE MAY RESULT IN REMOVAL AND ASSESSMENT OF COST TO THE PROPERTY PURSUANT TO K.S.A. 12-6a17.
- A SIGN SHALL BE POSTED ON THE FACILITY NOTING THE NAME AND TELEPHONE NUMBER OF THE TOWER OWNER/OPERATOR.
- THE TOWER OWNER/OPERATOR SHALL SUBMIT A LETTER TO THE PLANNING BY JULY 1 EACH YEAR LISTING THE CURRENT USERS AND TYPES OF TELECOMMUNICATION ANTENNA LOCATION ON THE FACILITY.
- THE TOWER WILL BE INSPECTED ANNUALLY AND A REPORT SHALL BE FILED WITH THE DIRECTOR OF PLANNING PER SECTION 20-529 (4) WHICH STATES; INSPECTIONS, ALL TELECOMMUNICATIONS FACILITIES SHALL BE INSPECTED ANNUALLY AT THE OWNER'S EXPENSE AND AN INSPECTION REPORT SHALL BE FILED WITH THE DIRECTOR OF PLANNING. ALL TELECOMMUNICATIONS FACILITIES MAY BE INSPECTED AT ANY TIME BY THE CODES ENFORCEMENT OFFICER IN ORDER TO DETERMINE COMPLIANCE WITH ORIGINAL CONSTRUCTION STANDARDS. DEVIATION FROM THE ORIGINAL CONSTRUCTION FOR WHICH A PERMIT IS OBTAINED CONSTITUTES A VIOLATION OF THIS CODE. NOTICE OF VIOLATIONS WILL BE SENT BY REGISTERED MAIL TO THE TELECOMMUNICATIONS FACILITY OPERATOR WHO WILL HAVE 30 DAYS FROM THE DATE THE NOTIFICATION IS ISSUED TO MAKE ADJUSTMENTS OF REPAIRS. THE OPERATOR SHALL NOTIFY THE CODES ENFORCEMENT OFFICER IN WRITING THAT THE ADJUSTMENTS OR REPAIRS HAVE BEEN MADE BY THE CODES ENFORCEMENT OFFICER TO ASSESS COMPLIANCE. THE OPERATOR SHALL THEN BE NOTIFIED OF THE RESULTS OF THE SECOND INSPECTION. AN APPEAL OF THE DECISION OF THE CODE ENFORCEMENT OFFICER CAN BE MADE TO THE BOARD OF ZONING APPEALS IN ACCORDANCE WITH SECTION 20-1311.
- THE TOWER WILL NOT HAVE TOWER LIGHTING OR BEACONS.

ZONING DRAWINGS 8-26-14

DRAWING INDEX

T-1	PROJECT INFORMATION, LOCATION MAPS, AND
	DRAWING INDEX

SP-1 LAND SURVEY

_SP-2 LAND SURVEY

C-2 TOWER ELEVATION AND ANTENNA INFORMATION

C-3 FENCE DETAILS

<u>C-4</u> <u>EQUIPMENT SHELTER PLAN</u>

ENLARGED SITE PLAN

C-5 EQUIPMENT SHELTER ELEVATIONS





ERTIFICATION:

PRELIMINARY
PRELIMINARY
CONSTRUCTION

RELEASE	
DATE	
02/25/14	LEASE EXHIBIT
03/19/14	SITE PLAN & TOWER ELEVATION
06/09/14	CONSTRUCTION DWGS - REV A
07/28/14	CONSTRUCTION DWGS - REV B
08/26/14	CONSTRUCTION DWGS - REV C

THIS DRAWING IS COPYRIGHTED AND IS THE SOLE PROPERTY OF THE OWNER. IT IS PRODUCED SOLELY FOR USE BY THE OWNER AND ITS AFFILIATES, REPRODUCTION OR USE OF THIS DRAWING AND/OR THE INFORMATION CONTAINED IN IT IS FORBIDDEN WITHOUT THE WRITTEN PERMISSION OF THE OWNER.

DRAWN BY: CMD CHECKED BY: DJH

SITE NAME:

LAWC BARKER CELL SITE

SITE ADDRESS

BULLENE AVE LAWRENCE, KS 66044

SHEET TITLE

PROJECT INFORMATION, LOCATION MAPS AND DRAWING INDEX

A&E PROJECT NO.:

001-1507

SHEET NO.:

T-1

PARENT PARCEL DESCRIPTION:

Lot A in Block 9 of Scott's Replat of Portions of Blocks 5 and 9 in Homewood Gardens, a Subdivision in the City of Lawrence, Douglas County, Kansas.

PROPOSED LESSEE'S LAND SPACE DESCRIPTION:

That part of Lot A in Block 9 of Scott's Replat of Portions of Blocks 5 and 9 in Homewood Gardens, a Subdivision in the City of Lawrence, Douglas County, Kansas and being more particularly described as follows:

Referring to the Southwest corner of said Lot A, a #4 rebar found for corner; thence northerly on an assumed bearing of North 05°28'03 East, on the westerly line of said Lot A, 54.34 feet; thence easterly North 87°44'19" East, 13.30 feet, to the Point of Beginning for the described Land Space; thence following the perimeter of the described Land Space on the following bearings and distances: North 02°15'41" West, 48.00 feet; thence North 87°44'19" East, 55.00 feet; thence South 02°15'41" East, 23.00 feet; thence North 87°44'19" East, 15.00 feet, thence South 02°15'41" East, 25.00 feet; thence South 87°44'19" West, 70.00 feet, to the Point of Beginning for the described Land Space.

Containing a total calculated area of 3,015 square feet or 0.069 acres, more or less.

LESSEE'S NON-EXCLUSIVE ACCESS/UTILITY RIGHT OF WAY DESCRIPTION:

A Non-Exclusive Access/Utility Right of Way, 25 feet in width, located in that part of Lot A in Block 9 of Scott's Replat of Portions of Blocks 5 and 9 in Homewood Gardens, a Subdivision in the City of Lawrence, Douglas County, Kansas and the centerline being more particularly described as follows:

Referring to the Southwest corner of said Lot A, a #4 rebar found for corner; thence northerly on an assumed bearing of North 05°28'03 East, on the westerly line of said Lot A, 54.34 feet; thence easterly North 87°44'19" East, 13.30 feet, to the Southwest corner of the described Land Space; thence South 02°15'41" East, 12.50 feet, to the Point of Beginning of the centerline for the described Right of Way; thence easterly North 87°44'19" East, 163.07 feet, to a point of intersection on the westerly right-of-way line of Bullene Avenue, also being the Point of Termination for the centerline of the described Right of Way.

Containing a total calculated area of 4,077 square feet or 0.094 acres, more or less.

INFORMATIONAL REPORT:

Based on Commitment for Title Insurance with an effective date of December 3, 2013 provided by First American Title Insurance Company, Commitment No. NCS-643273-KCTY, the following are of survey matters:

- 9. A Claim and Proof of Ownership recorded March 10, 2009 in Book 1046 at Page 148 concerning the abandoned railroad easement. Does not affect the Land Space and Right of Way.
- 10. Easements, restrictions and setback lines as per plat, Plat Book 13 at Page 80. Affects Land Space, and shown hereon.


SURVEYORS NOTES

- 1.) Generally located in Missouri State Plane Coordinate System, West Zone (NAD-83).
- 2.) Not a survey of the parent parcel shown, but to be used only for the purposes shown hereon.
- 3.) The Utility locations shown hereon were determined by observed above ground evidence only. The surveyor was provided with above ground markings to determine any subsurface locations, and makes no guarantee that the underground utilities in the area, either in service or abandoned. The surveyor further does not warrant that the underground utilities shown are in the exact location indicated. This surveyor has not physically located the underground utilities.

Zoning Information: IG: General Industrial

Flood Information

Property falls within a Zone "X" (Minimal risk areas outside the 1-percent and .2-percent-annual-chance floodplains. No BFEs or base flood depths are shown within these zones) as determined by FEMA Flood Rate Map No. 20045C0178D, effective 8/05/10.

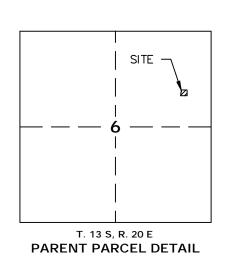

Surveyor's Certificate

Lessee's

-S 02°15'41" E 23.00'

Land Space

87°44'19" E

02°15'41" E

15.00

I, Jayme M. Malone, a Professional Registered Land Surveyor under the laws of the State of Kansas, certify the above survey was executed by me, on the date shown. Distances shown are measured in feet and decimals of a foot.

Signed this _____ day of ______, 20 ____.

Jayme M. Malone LS KS #1113




Prepared for

- 2°26' F



CHE	CKED BY:	JMM	
APP	ROVED BY:	JMM	
#	DATE	DESCRIPTION	INT
1	1/16/14	80% Prelim	TH
2	2/06/14	Add Land Space/R.O.W.	MG
3	2/26/14	Add Title	MG
4		Comments	TH
5	7/18/14	Lease Area	MG

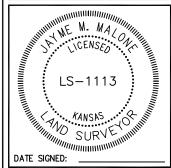

SITE NAME: LAWC BARKER

SITE NUMBER:


SITE ADDRESS: 1725 BULLENE AVE., LAWRENCE, KS 66044


SHEET NAME:

SITE PLAN

SHEET NUMBER:

SP-1

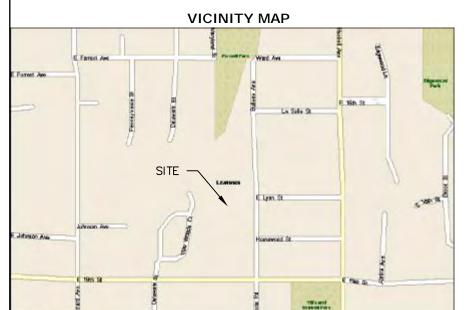

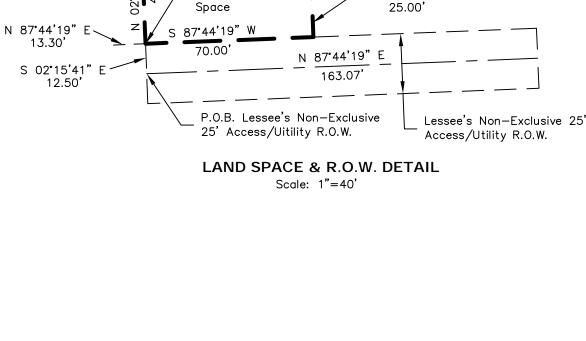


N 87'44'19"

55.00


P.O.B.


Land

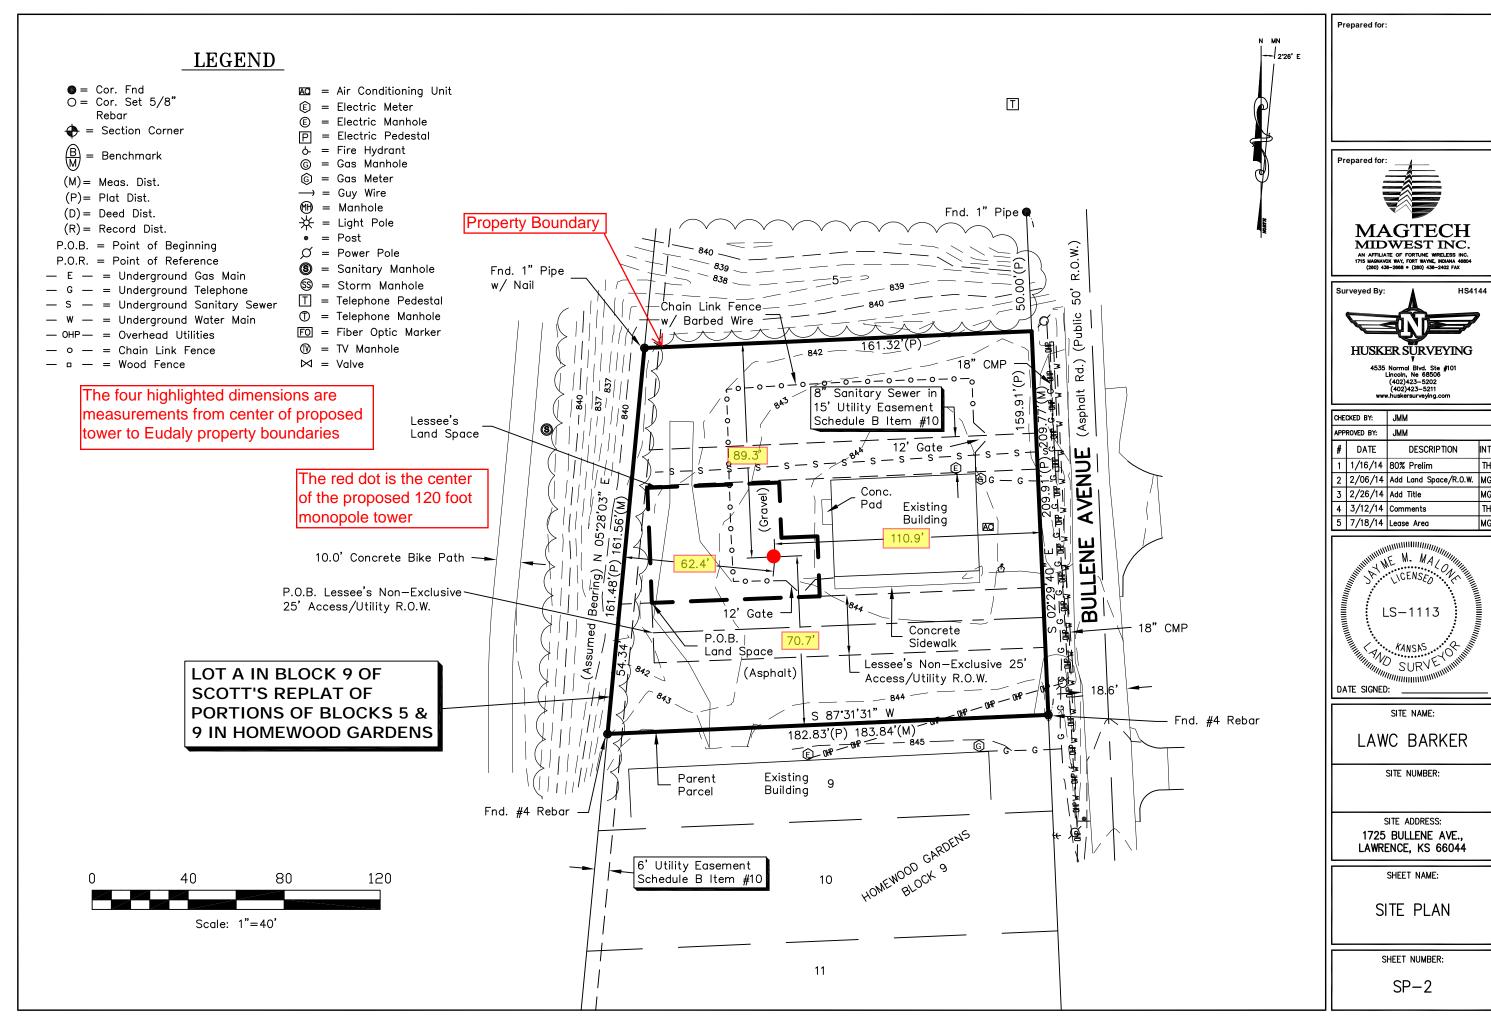



CHE	CKED BY:	JMM	
APP	ROVED BY:	JMM	
#	DATE	DESCRIPTION	IN
1	1/16/14	80% Prelim	TI
2	2/06/14	Add Land Space/R.O.W.	М
3	2/26/14	Add Title	М
4	3/12/14	Comments	TI
5	7/18/14	Lease Area	М

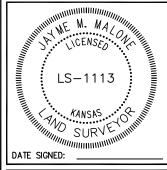

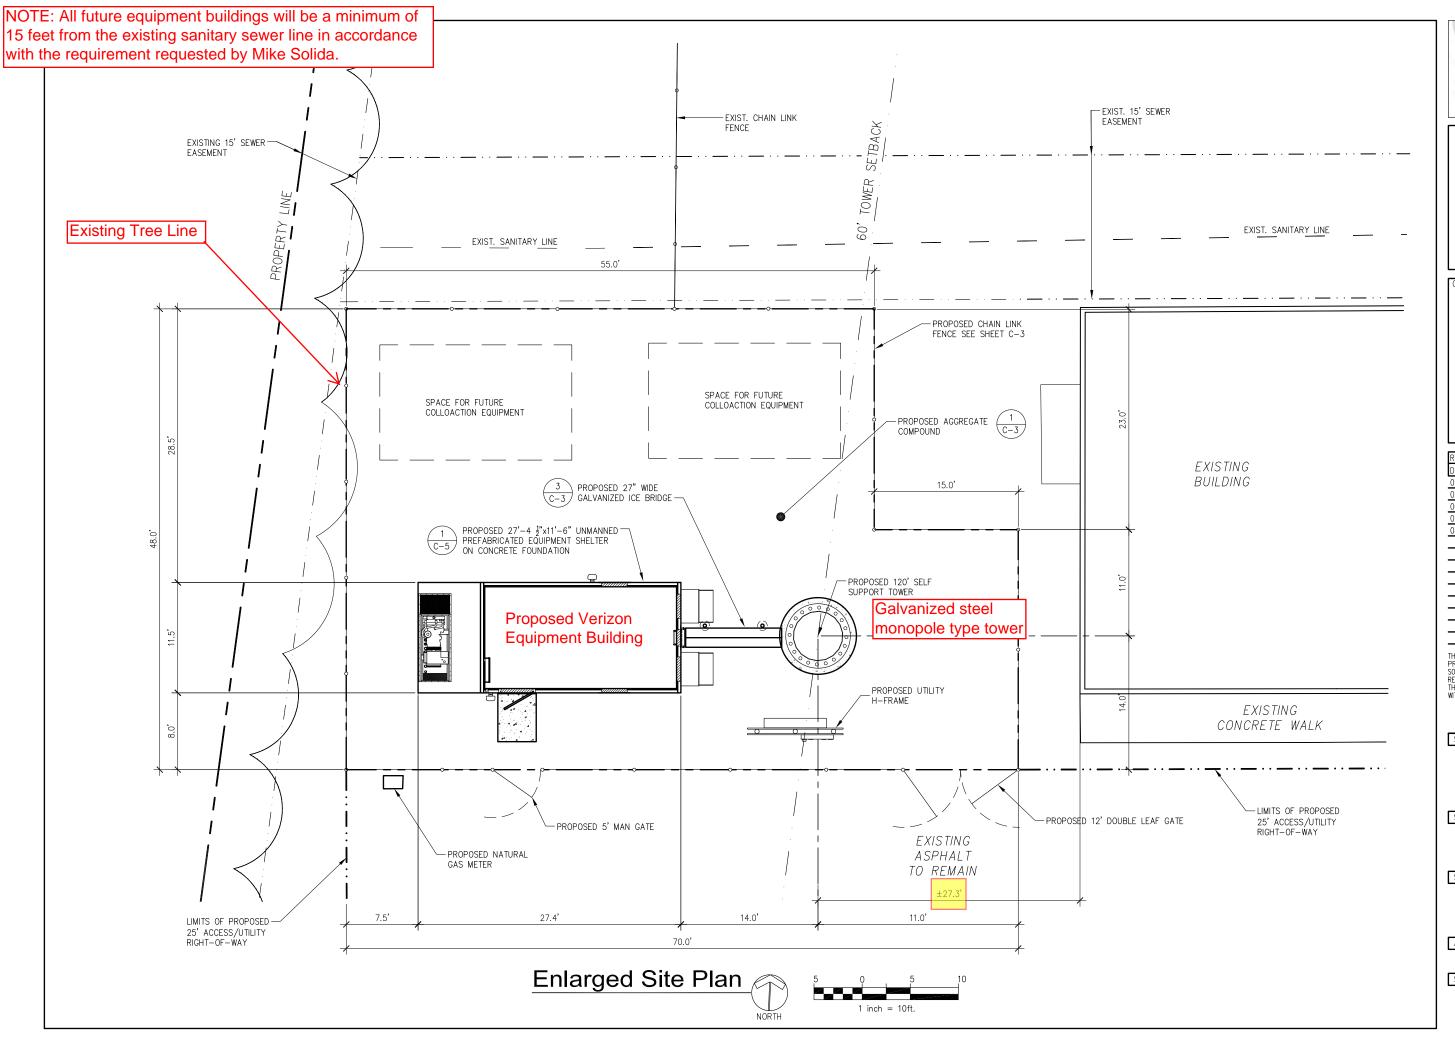





CERTIFICATION:

PRELIMINARY
CONSTRUCTION

RELEASE	
DATE	
02/25/14	LEASE EXHIBIT
03/19/14	SITE PLAN & TOWER ELEVATION
06/09/14	CONSTRUCTION DWGS - REV A
07/28/14	CONSTRUCTION DWGS - REV B
08/26/14	CONSTRUCTION DWGS - REV C

THIS DRAWING IS COPYRIGHTED AND IS THE SOLE PROPERTY OF THE OWNER. IT IS PRODUCED SOLELY FOR USE BY THE OWNER AND ITS AFFILIATES. REPRODUCTION OR USE OF THIS DRAWING AND/OR THE INFORMATION CONTAINED IN IT IS FORBIDDEN WITHOUT THE WRITTEN PERMISSION OF THE OWNER.

DRAWN BY: CMD CHECKED BY: DJH

SITE NAME:

LAWC BARKER CELL SITE

SITE ADDRESS:

BULLENE AVE LAWRENCE, KS 66044

SHEET TITLE:

ENLARGED SITE PLAN


A&E PROJECT NO.:


001-1507

SHEET NO.:

C-1

DD 0 D 0 C	ED ANTEN	IN A WEW																								
PROPOS	ED ANTEN	NA KEY	Antenna																				Hybrid	Hybrid	Hybrid	
			Centerline		Antenna	Height	Width	Depth	Weight		Mech	Electrical		TMA		Coax	Coax Coax		RRU	Distribution Box			Cable	Cable		
	Position		(ft AGL)	Antenna Make / Model	Count	(in)	(in)	(in)		Azimuth	100000-000-0000		TMA Make/Model	Count	Coax Make/Model	12200 20000000	Size Length	RRU Make/Model	Count	Make/Model	Raycap Count	Hybrid Cable Make/Model	Count		Length	
Mainline																		RRUS B13	3	RFS DB-B1-6C-12AB-0Z	4(2 on tower, 2 in shelter	RFS Hybriflex HBF058-08U1S2-14F	6	5/8"		
Cable &																						RFS Hybriflex HBF114-13U6S12-150F	2	1-1/4"		
Distributio	n ////////////////////////////////////																							15 ft	1/2"	12
Distribution																										1
	Δ	proposed	120	Andrew LNX-8515DS-A1M-02(CDMA)	4	96.4	11.9	7.1	49.8	330	2	0			1	1										
	В	proposed		Andrew Elivera 150 5-A IMPOZ(CBINIA)	,	50.4	11.5	0.1	40.0	220	-													$\overline{}$	\rightarrow	
Alpha Sect	or C	proposed	120	Air - 32(AW S)	1	57	12	8	99	330	0	0												$\overline{}$	$\overline{}$	
		proposed	50.090	Andrew LNX-8515D S-A 1M-02(LTE)	1	96.4	11.9	7.1	49.8	330	2	0												$\overline{}$	\rightarrow	
			02//1000			7,000,000				00000										Ja						
	E	proposed	120	Andrew LNX-6515DS-A1M-02(CDMA)	1	96.4	11.9	7.1	49.8	90	0	0														
Beta Secto	F																									
Deta Jecto	" G	proposed	120	Air - 32(AW S)	1.	57	12	8	99	90	0	0														
	Н	proposed	120	Andrew LNX-8515DS-A1M-02(LTE)	1	96.4	11.9	7.1	49.8	90	0	0														
			100			00.4	44.0		40.0	240			ı		1											
Commo		proposed	120	Andrew LNX-8515D S-A1M-02(CDMA)	1	96.4	11.9	7.1	49.8	210	0	U					 							$\overline{}$		
Gamma Sector	J V		120	Air - 32(AW S)		57	12	0	99	210		0											-	$\overline{}$		
settor	K	proposed	120 120	Andrew LNX-6515D S-A1M-02(LTE)	1	96.4	11.9	7.1	49.8	210	0	0												$\overline{}$	-	
	L	proposed	120	Antenna Tota	1 0	50.4	11.9	7.1	43.8	210	U	U	TMA Total	•	Coax Tota			RRU Tota		Distro Box Total	3	Hybrid Cable Tota	1 8	lime	per Total	12

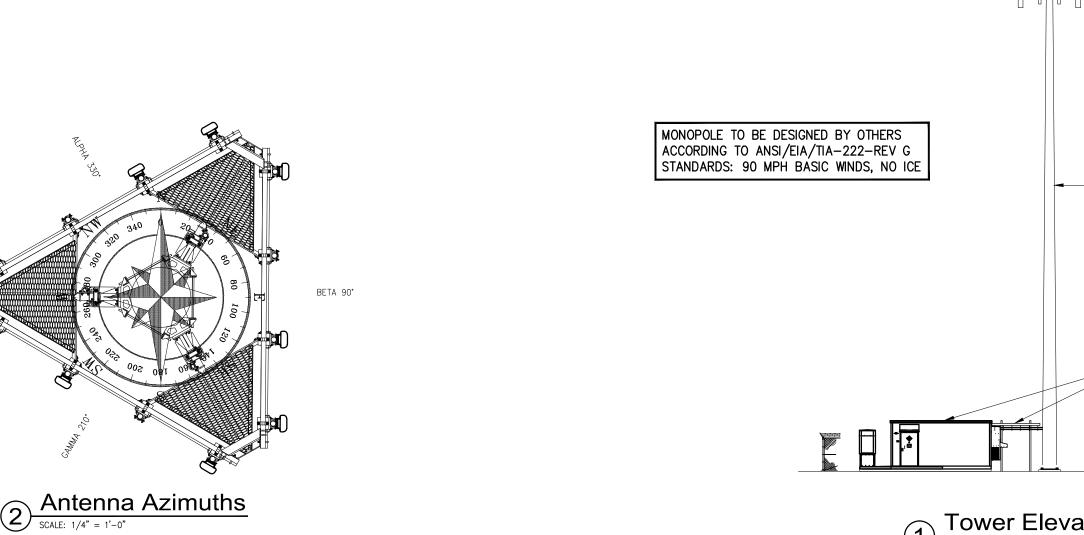

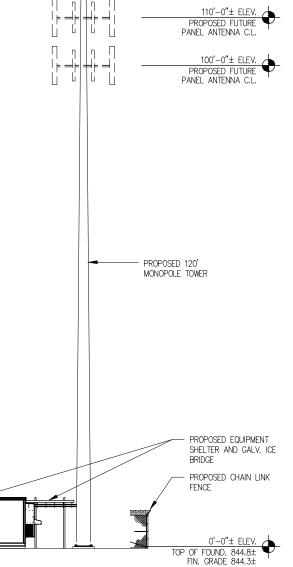

130'-0"± ELEV.

TIP OF LIGHTNING ROD
(NOT TO EXCEED FAA MAX. HGT.)

120'-0"± ELEV.
PROPOSED TOP OF TOWER
PANEL ANTENNA C.L.





PRELIMINARY
CONSTRUCTION |

RELEASE	
DATE	
02/25/14	LEASE EXHIBIT
03/19/14	SITE PLAN & TOWER ELEVATION
05/07/14	CONSTRUCTION DWGs - REV A
06/26/14	CONSTRUCTION DWGs - REV B
-	

THIS DRAWING IS COPYRIGHTED AND IS THE SOLE PROPERTY OF THE OWNER. IT IS PRODUCED SOLELY FOR USE BY THE OWNER AND ITS AFFILIATES. REPRODUCTION OR USE OF THIS DRAWING AND/OR THE INFORMATION CONTAINED IN IT IS FORBIDDEN WITHOUT THE WRITTEN PERMISSION OF THE OWNER.

DRAWN BY: CMD CHECKED BY: DJH

SITE NAME:

LAWC BARKER **CELL SITE**

SITE ADDRESS:

BULLENE AVE LAWRENCE, KS 66044

SHEET TITLE:

TOWER ELEVATION, ANTENNA INFORMATION, NOTES AND DETAILS

A&E PROJECT NO.:


001-1507

SHEET NO.:

C-2

Tower Elevation

SCALE: 1" = 20'-0"

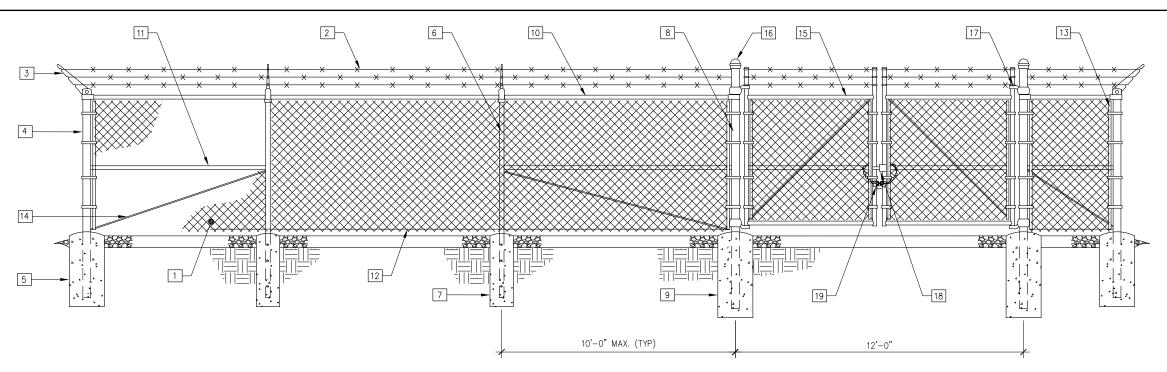


Typical Fence Elevation NO SCALE

Keynote Legend


- 1 FABRIC: 9 GAUGE, 2" MESH, ASTM A392 (SEE FENCE SECTION FOR HEIGHT).
- BARBED WRE: 12 GAUGE WRE, 4 POINT (3 RUNS), FINISH TO MATCH FABRIC, ASTM A121.
- $\fbox{3}$ EXTENSION ARMS: STAMPED STEEL WITH MALLEABLE IRON BASE, FINISH TO MATCH FENCE FRAMEWORK, ASTM F626.
- 4 END AND CORNER POSTS: 3"Ø PIPE SCH. 40 (GALV.) ASTM F1083
- 5 CONCRETE FOUNDATION: 36"x12"ø (3000 PSI)
- 6 LINE POSTS: 2"Ø PIPE SCH. 40 (GALV.) ASTM F1083
- CONCRETE FOUNDATION: 36"x10"ø (3000 PSI)
- 8 GATE POSTS: 4"Ø PIPE SCH. 40 (GALV.) ASTM F1083
- 9 CONCRETE FOUNDATION: 48"x12"ø (3000 PSI)
- 10 TOP RAIL & BRACE RAIL: 1-1/2" PIPE SCH. 40 (GALV.) ASTM F1083
- 11 MIDDLE RAILS: 1-1/2" PIPE SCH. 40 (GALV.) ASTM F1083
- 12 BOTTOM TENSION WIRE: 0.177" METALLIC-COATED STEEL (GALV.), MARCFILED. ASTM A824
- $\fbox{13}$ TENSION BARS: 3/16"x3/4", FULL HEIGHT OF FABRIC, FINISH TO MATCH FENCE FRAMEWORK.
- 14 TENSION ROD: 3/8" WITH ADJ. TIGHTNER, FINISH TO MATCH FENCE FRAMEWORK.
- 15 GATE FRAME: 2"Ø SCH. 40 (GALV.) ASTM F1083
- 16 POST CAPS: PER POST DIAMETER.
- 17 GATE HINGES: NON-LIFT-OFF TYPE, OFFSET TO PERMIT 180 DEGREE SWING.
- DAC INDUSTRIES 615-C ELEVENTH STREET, GRAND RAPIDS, MI 49504
- 19 LOCK CHAIN: 3/8" SIZE, 36" LONG HOT DIP GALVANIZED ZINC COATED. W/MARINE-GRADE PROGRAMMABLE FOUR DIGIT PADLOCK (SESAME BRAND OR APPROVED EQUAL)

NOTES:

- 1. REFER TO PROJECT SPECIFICATIONS FOR INFORMATION NOT SHOWN IN THE DRAWING.
- 2. FENCE FABRIC SHALL COMFORN TO CHAIN LINK FENCE MANUFACTURERS INSTITUTE (CLFMI) PRODUCT MANUAL.
- 3. INSTALL FENCE IN COMPLIANCE WITH ASTM F 567.
- 4. INSTALL SWING GATES IN COMPLIANCE WITH ASTM F 900.
- 5. DO NOT BEGIN INSTALLATION AND ERECTION BEFORE FINAL GRADING IS COMPLETED, UNLESS OTHERWISE PERMITTED. INSTALL FENCING ON BOUNDARY LINES INSIDE OF PROPERTY LINE ESTABLISHED BY SURVEY.
- 6. DRILL OR HAND-EXCAVATE (USING POST HOLE DIGGER) HOLES FOR POSTS TO DIAMETERS AND SPACINGS INDICATED, IN FIRM, UNDISTURBED OR COMPACTED SOIL. IF NOT INDICATED ON DRAWINGS, EXCAVATE HOLES FOR EACH POST TO MINIMUM DIAMETER RECOMMENDED BY FENCE MANUFACTURER, BUT NOT LESS THAN (4) TIMES LARGEST GROSS-SECTION OF POST.
- 7. REMOVE POST HOLE SPOILS FROM SITE. DO NOT SET SPOILS ON AGGREGATE WITHOUT ADEQUATE PROTECTION.
- 8. PROTECT PORTION OF POSTS ABOVE GROUND FROM CONCRETE SPLATTER. PLACE CONCRETE AROUND POSTS AND VIBRATE OR TAMP FOR CONSOLIDATION. CHECK EACH POST FOR VERTICAL AND TOP ALIGNMENT AND HOLD IN POSITION DURING PLACEMENT AND FINISHING OPERATIONS, UNLESS OTHERWISE SHOWN, EXTEND CONCRETE FOOTING 1 INCH ABOVE GRADE AND TROWEL TO A CROWN TO SHED WATER.
- 9. INSTALL BARBED WIRE IN ACCORDANCE WITH MANUFACTURER'S INSTRUCTIONS.
- 10. APPLY FABRIC TO OUTSIDE OF FRAMEWORK.

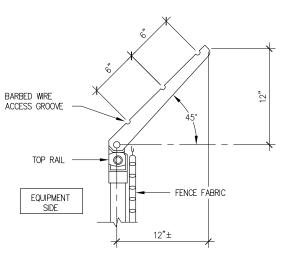



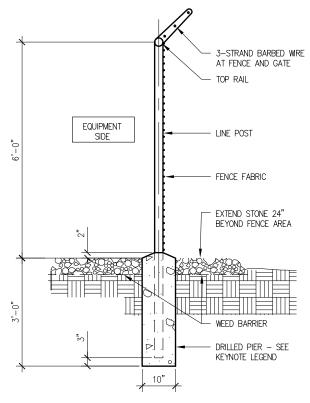

Typical Fence Section

SCALE: 3/8" = 1'-0"





PRELIMINARY
CONSTRUCTION

RELEASE	
DATE	
	LEASE EXHIBIT
03/19/14	SITE PLAN & TOWER ELEVATIO
06/09/14	CONSTRUCTION DWGS - REV A
07/28/14	CONSTRUCTION DWGS - REV E
08/26/14	CONSTRUCTION DWGS - REV (

THIS DRAWING IS COPYRIGHTED AND IS THE SOLE PROPERTY OF THE OWNER. IT IS PRODUCED SOLELY FOR USE BY THE OWNER AND ITS AFFILIATES. REPRODUCTION OR USE OF THIS DRAWING AND/OR THE INFORMATION CONTAINED IN IT IS FORBIDDEN WITHOUT THE WRITTEN PERMISSION OF THE OWNER.

DRAWN BY: CMD CHECKED BY: DJH

SITE NAME:

LAWC BARKER CELL SITE

SITE ADDRESS:

BULLENE AVE LAWRENCE, KS 66044

SHEET TITLE:


FENCE DETAILS

A&E PROJECT NO.:

SHEET NO.:

001-1507

C-3

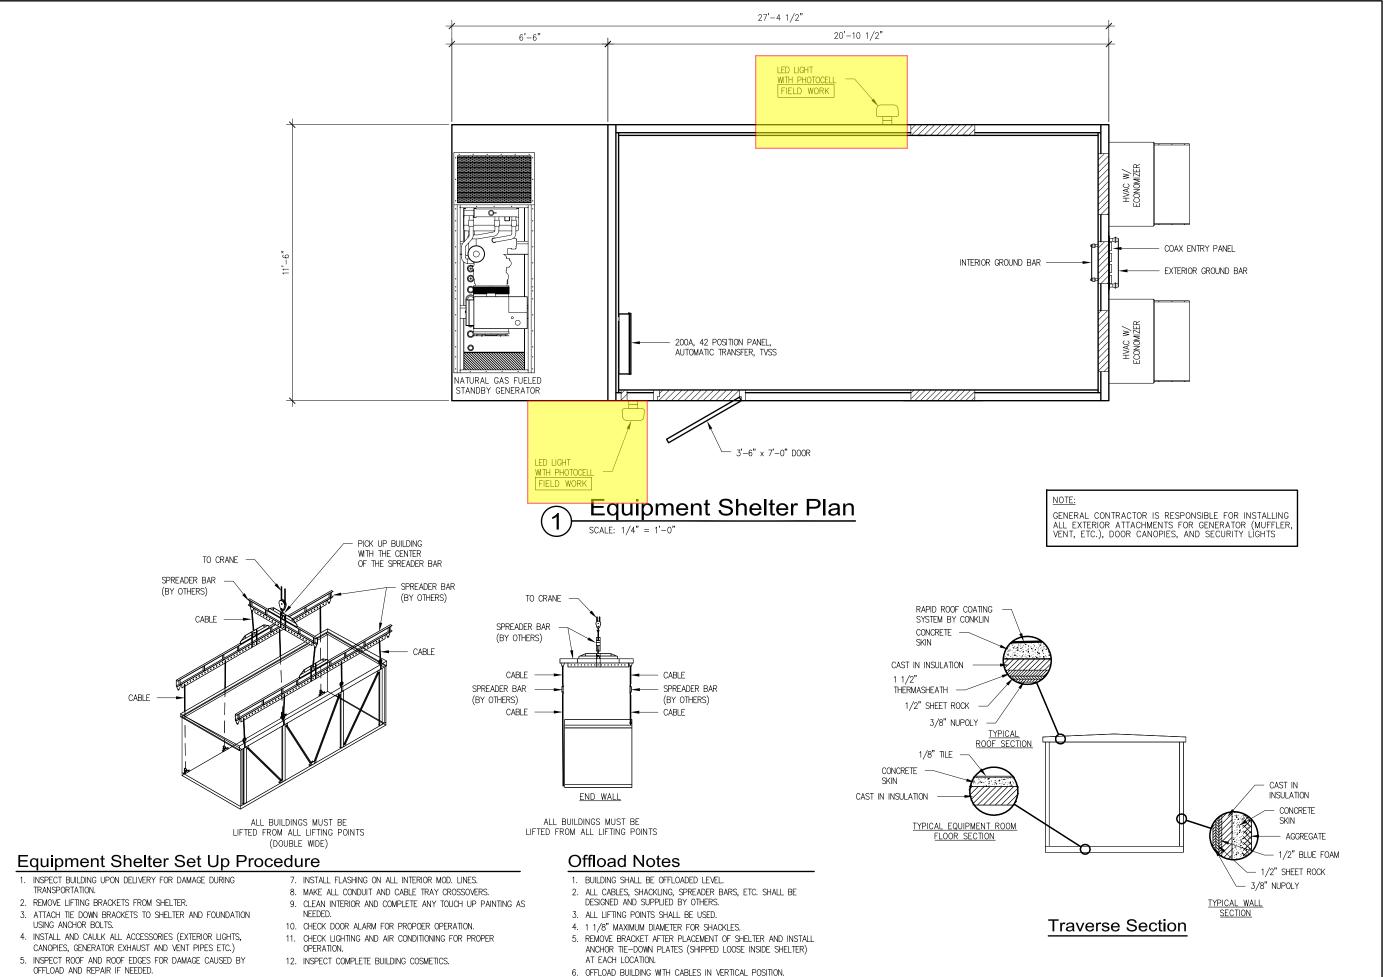

ANGLED POSITION CABLES ARE NOT ACCEPTABLE.

6. INSTALL BACKER ROD AND CAULK EXTERIOR WALLS AND ROOF.





CERTIFICATION:

FOR REFERENCE

RELEASE DATE 02/25/14 LEASE EXHIBIT 03/19/14 SITE PLAN & TOWER ELEVA 06/09/14 CONSTRUCTION DWGS - RE 07/28/14 CONSTRUCTION DWGS - RE 08/26/14 CONSTRUCTION DWGS - RE	
03/19/14 SITE PLAN & TOWER ELEVA 06/09/14 CONSTRUCTION DWGS - RE 07/28/14 CONSTRUCTION DWGS - RE	
06/09/14 CONSTRUCTION DWGS - RE 07/28/14 CONSTRUCTION DWGS - RE	
07/28/14 CONSTRUCTION DWGS - RE	TIO
	/ /
08/26/14 CONSTRUCTION DWGS - RE	/ E
	/ (

THIS DRAWING IS COPYRIGHTED AND IS THE SOLE PROPERTY OF THE OWNER. IT IS PRODUCED SOLELY FOR USE BY THE OWNER AND ITS AFFILIATES. REPRODUCTION OR USE OF THIS DRAWING AND/OR THE INFORMATION CONTAINED IN IT IS FORBIDDEN WITHOUT THE WRITTEN PERMISSION OF THE OWNER.

DRAWN BY: CMD CHECKED BY: DJH

SITE NAME:

LAWC BARKER **CELL SITE**

SITE ADDRESS:

BULLENE AVE LAWRENCE, KS 66044


SHEET TITLE:

EQUIPMENT SHELTER PLAN

A&E PROJECT NO.:

001-1507

SHEET NO.:

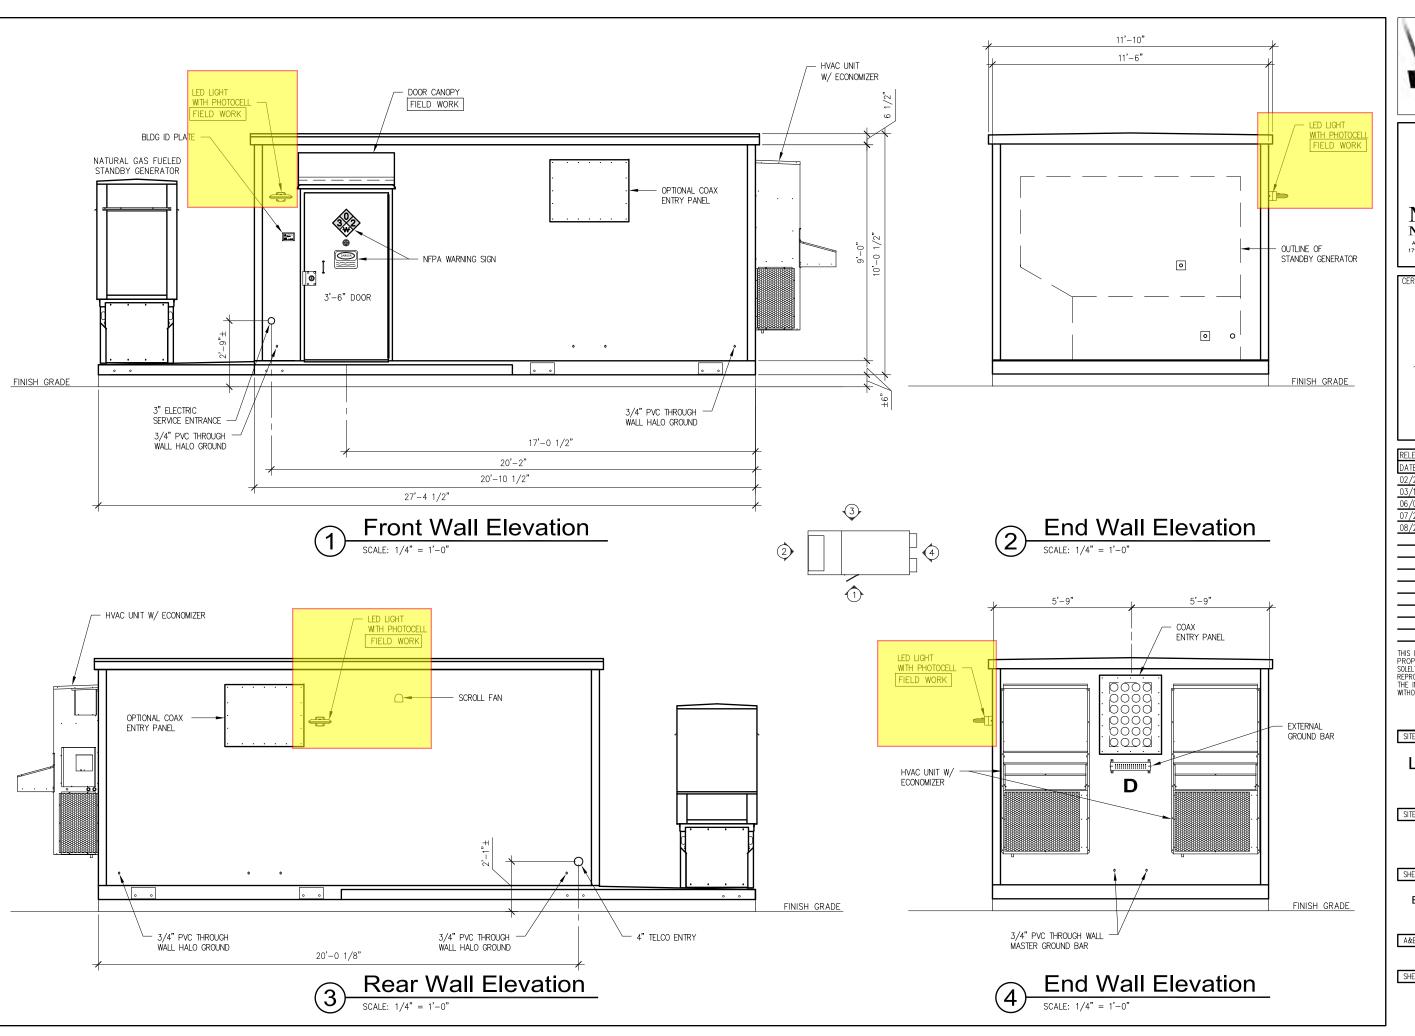





CERTIFICATION:

FOR REFERENCE
ONLY

RELEASE
DATE
02/25/14 LEASE EXHIBIT
03/19/14 SITE PLAN & TOWER ELEVATION
06/09/14 CONSTRUCTION DWGS - REV A
07/28/14 CONSTRUCTION DWGS - REV B
08/26/14 CONSTRUCTION DWGS - REV C

THIS DRAWING IS COPYRIGHTED AND IS THE SOLE PROPERTY OF THE OWNER. IT IS PRODUCED SOLELY FOR USE BY THE OWNER AND ITS AFFILIATES. REPRODUCTION OR USE OF THIS DRAWING AND/OR THE INFORMATION CONTAINED IN IT IS FORBIDDEN WITHOUT THE WRITTEN PERMISSION OF THE OWNER.

DRAWN BY: CMD CHECKED BY: DJH

SITE NAME:

LAWC BARKER CELL SITE

SITE ADDRESS:

BULLENE AVE LAWRENCE, KS 66044

SHEET TITLE:

EQUIPMENT SHELTER ELEVATIONS

A&E PROJECT NO.:

001-1507

SHEET NO.:

C-5